


Bamboo Barrage at Outlet	40 m	
Earthen Bund	0 m	
Desilting	0 Cu. m	
Deweeding	101194 Sq. m	
Fish Rearing Tank	3 Nos. (50 m X 30 m)	
ish Landing Cum Community Hall	1 Nos	
Pen Culture	6 Nos	
Vermicompost Pit	-	
Approach Road	115 m	
Demarcation Pillar	150 Nos	

BOUNDARY	
ROAD	
RAILWAY	####
BENCH MARK	Ø
CULVERT	$\overline{}$
BRIDGE	
BEEL	*********
DEMARCATION OF BEEL AS PER RECORDS	
WATER BODIES (POND)	*******
VEGETATION / MARSHY AREAS	
HOUSES/ BUILDING	
CATCHMENT AREA	
PROP. BUND	
PROP. SILT TRAP AT INLET	000
PROP. BAMBOO BARRAGE AT OUTLET	00000
PROP. APPROACH ROAD	
PROP. FISH REARING TANK	
PROP. FISH LANDING CUM COMMUNITY HALL	

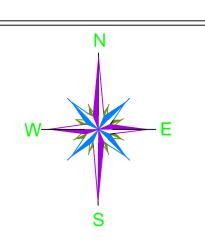

PACKAGE NO.:

NAME OF THE BEEL: SANTIJAAN BEEL

DEVELOPMENT BLOCK: BATADRAVA

REVENUE VILLAGE:

BATADRAVA BORHISA, BATADRAVA SARUHISA, BHUMURAGURI & HAIDUBI PATHAR

NAGAON

AREA (Ha):

12.80 Ha

PROJECT TITLE: Sustainable Wetlands and Integrated Fisheries Transformation (SWIFT) Project






DWG TITLE:

MASTERPLAN LAYOUT OF SANTIJAAN BEEL

DATE: CHECKED BY: SUBMITTED RECOMMENDED APPROVED TO: BY: BY: DATE: DATE: DATE: DATE: TEAM LEAD E.E.



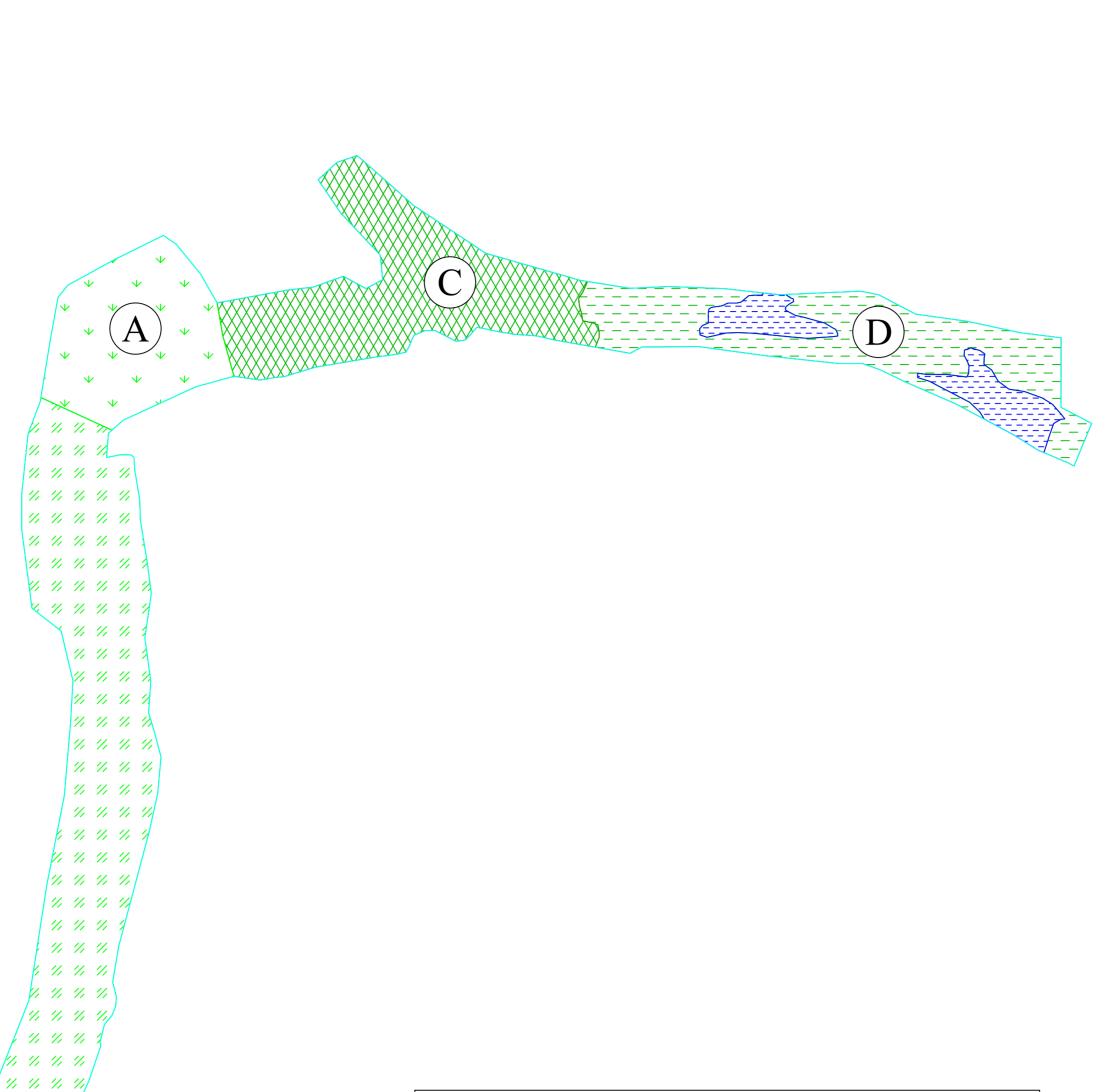

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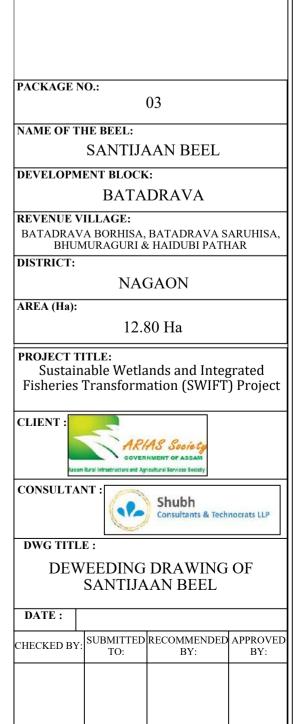
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	AREA DETAILS			
SYMBOL	DESCRIPTION	AREA (Sq. m)		
A	Thin and floating water hyacinths and other aquatic weeds etc.	13799.00		
B	Thick and floating water hyacinths and other aquatic weeds etc.	73339.00		
<u>C</u>	Thick and floating Taranies, Dalanies, Pitanies and other marginal aquatic weeds etc. upto a depth of 50 cm.	20297.00		
D	Medium and floating Taranies, Dalanies, Pitanies and other marginal aquatic weeds etc. upto a depth of 50 cm to 80 cm	15607.00		
E	Heavy and floating Taranies, Dalanies, Pitanies and other marginal aquatic weeds etc. upto a depth of 80 cm to 120 cm	0.00		

LEGENDS:

BEEL BOUNDARY	
WATER AREA	***************************************
THIN AND FLOATING WATER HYACINTHS AND OTHER AQUATIC WEEDS ETC.	
THICK AND FLOATING WATER HYACINTHS AND OTHER AQUATIC WEEDS ETC.	
THICK AND FLOATING TARANIES, DALANIES, PITANIES AND OTHER MARGINAL AQUATIC WEEDS ETC. UPTO A DEPTH OF 50 cm.	
MEDIUM AND FLOATING TARANIES, DALANIES, PITANIES AND OTHER MARGINAL AQUATIC WEEDS ETC. UPTO A DEPTH OF 50 cm to 80 cm.	20000000
HEAVY AND FLOATING TARANIES, DALANIES, PITANIES AND OTHER MARGINAL AQUATIC WEEDS ETC. UPTO A DEPTH OF 80 cm to 120 cm.	++++



DATE:

TEAM LEAD


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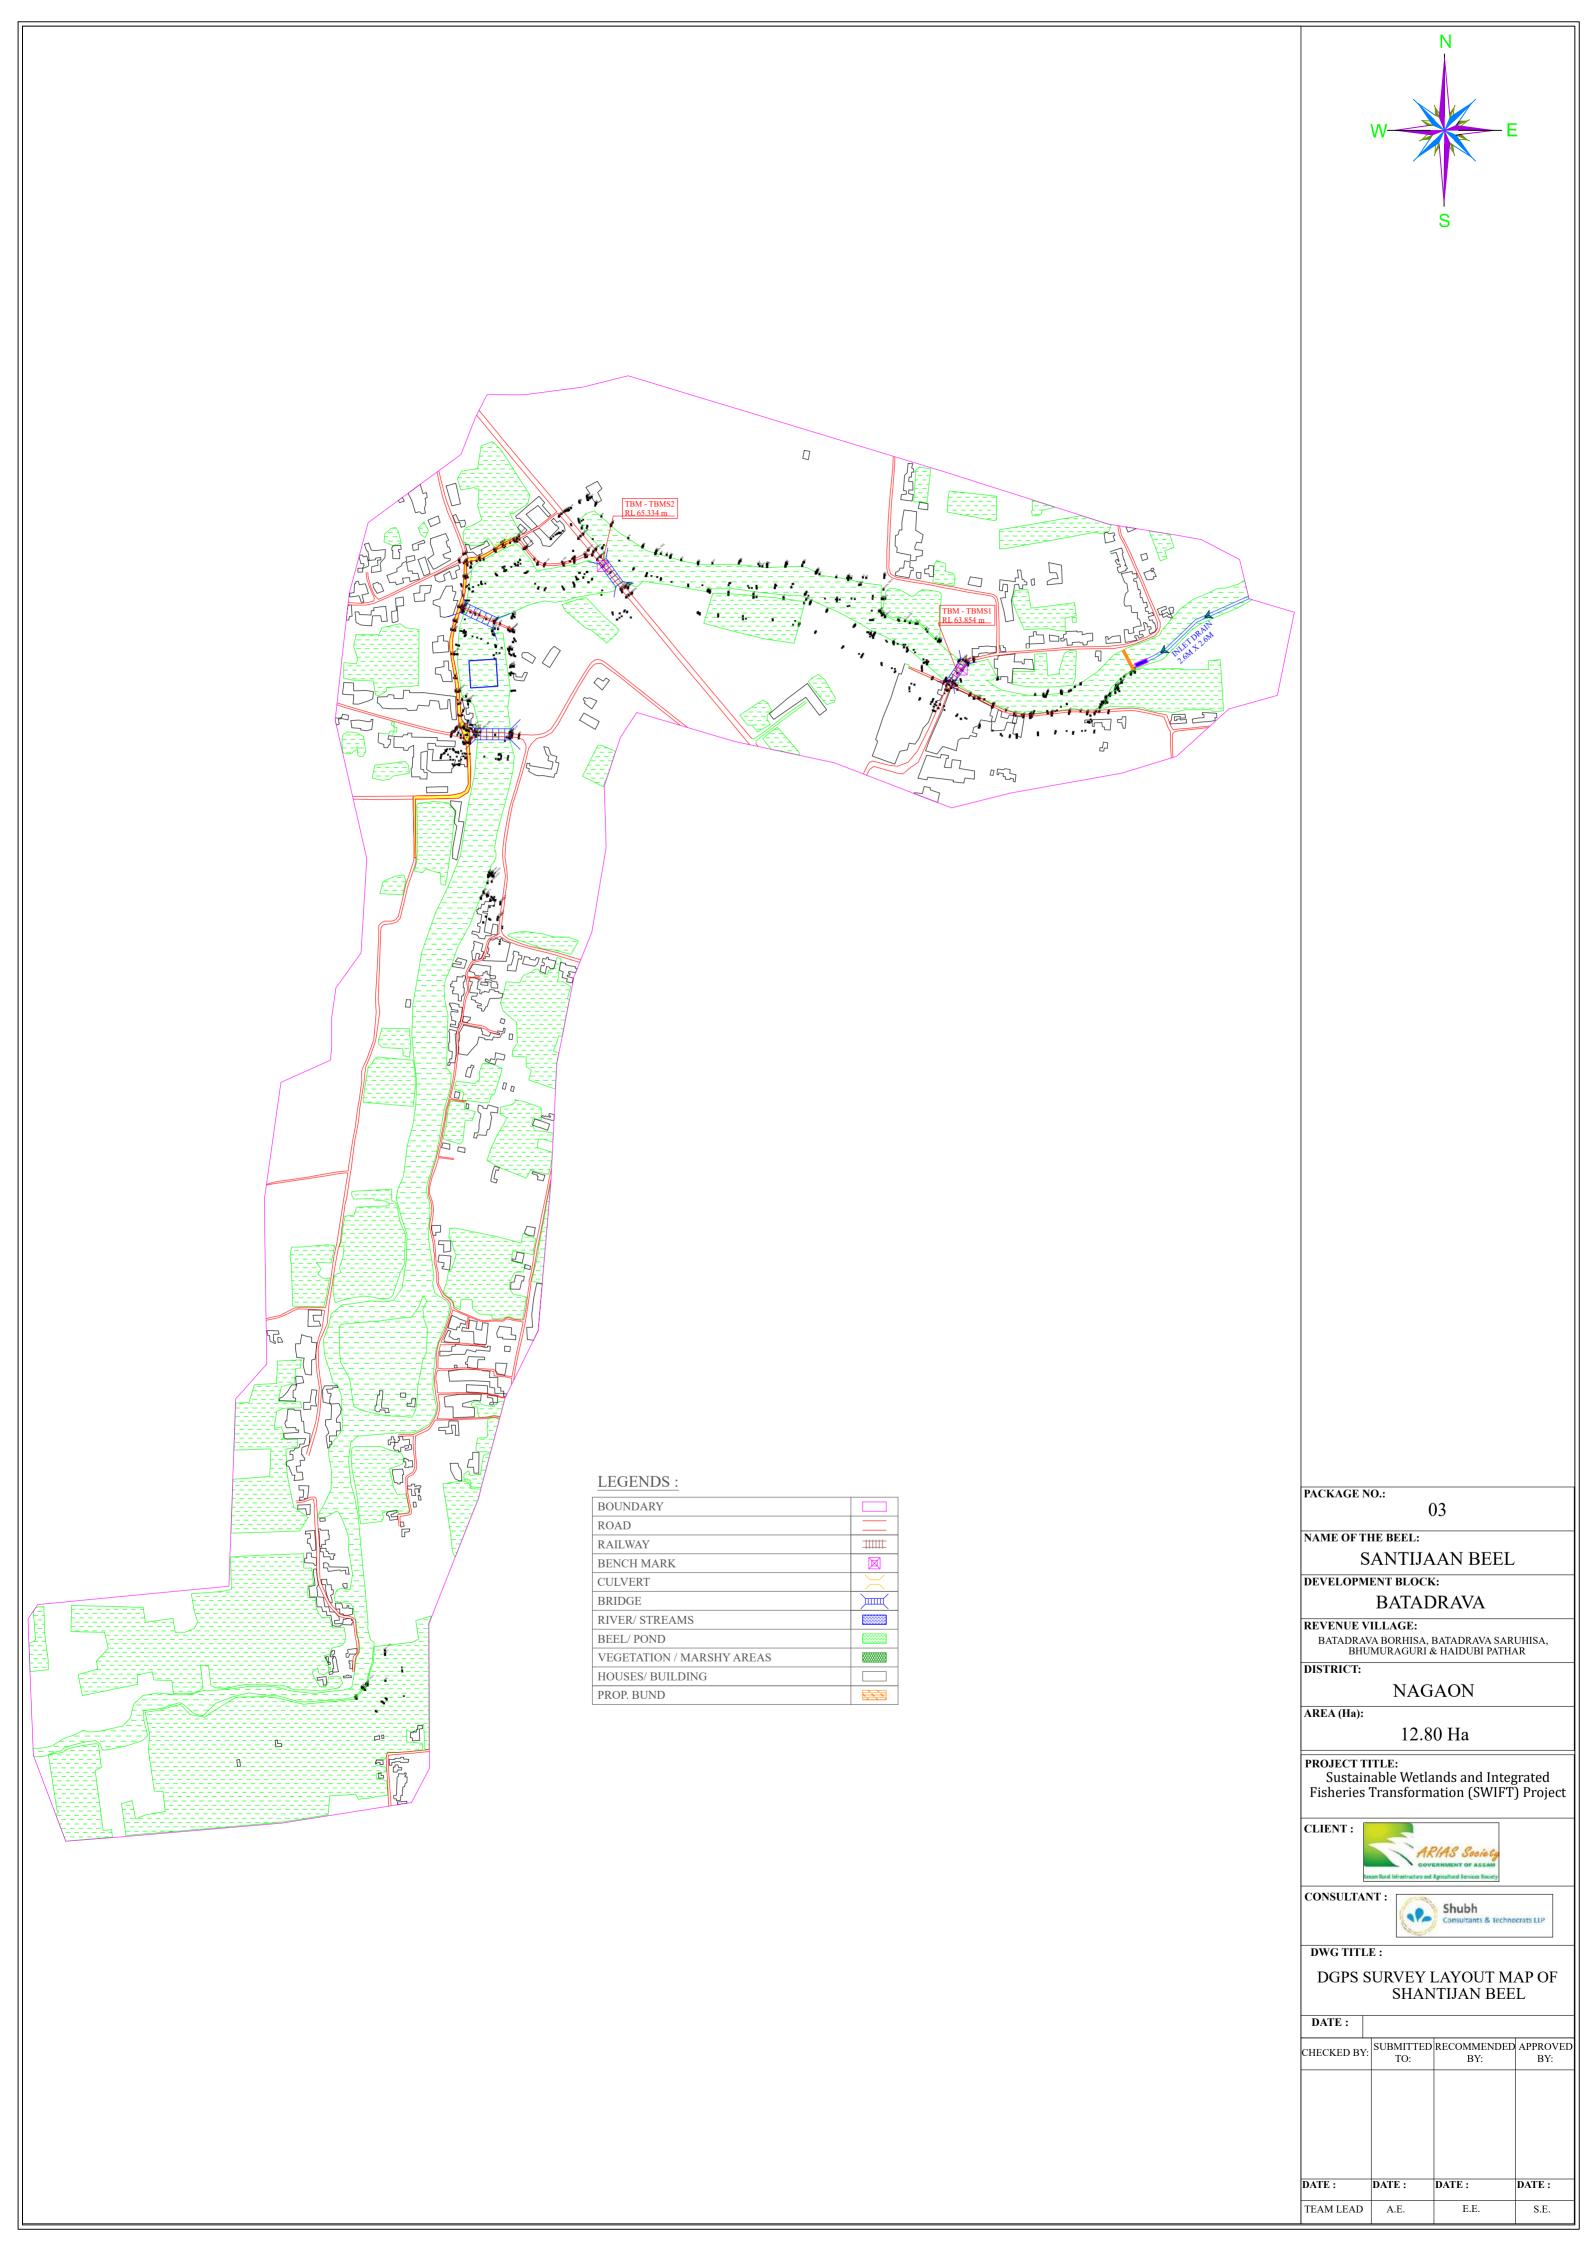
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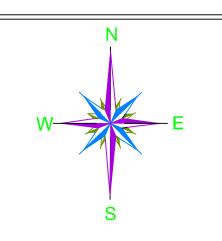
DATE:

S.E.





DRONE SURVEY MAP OF SANTIJAAN BEEL

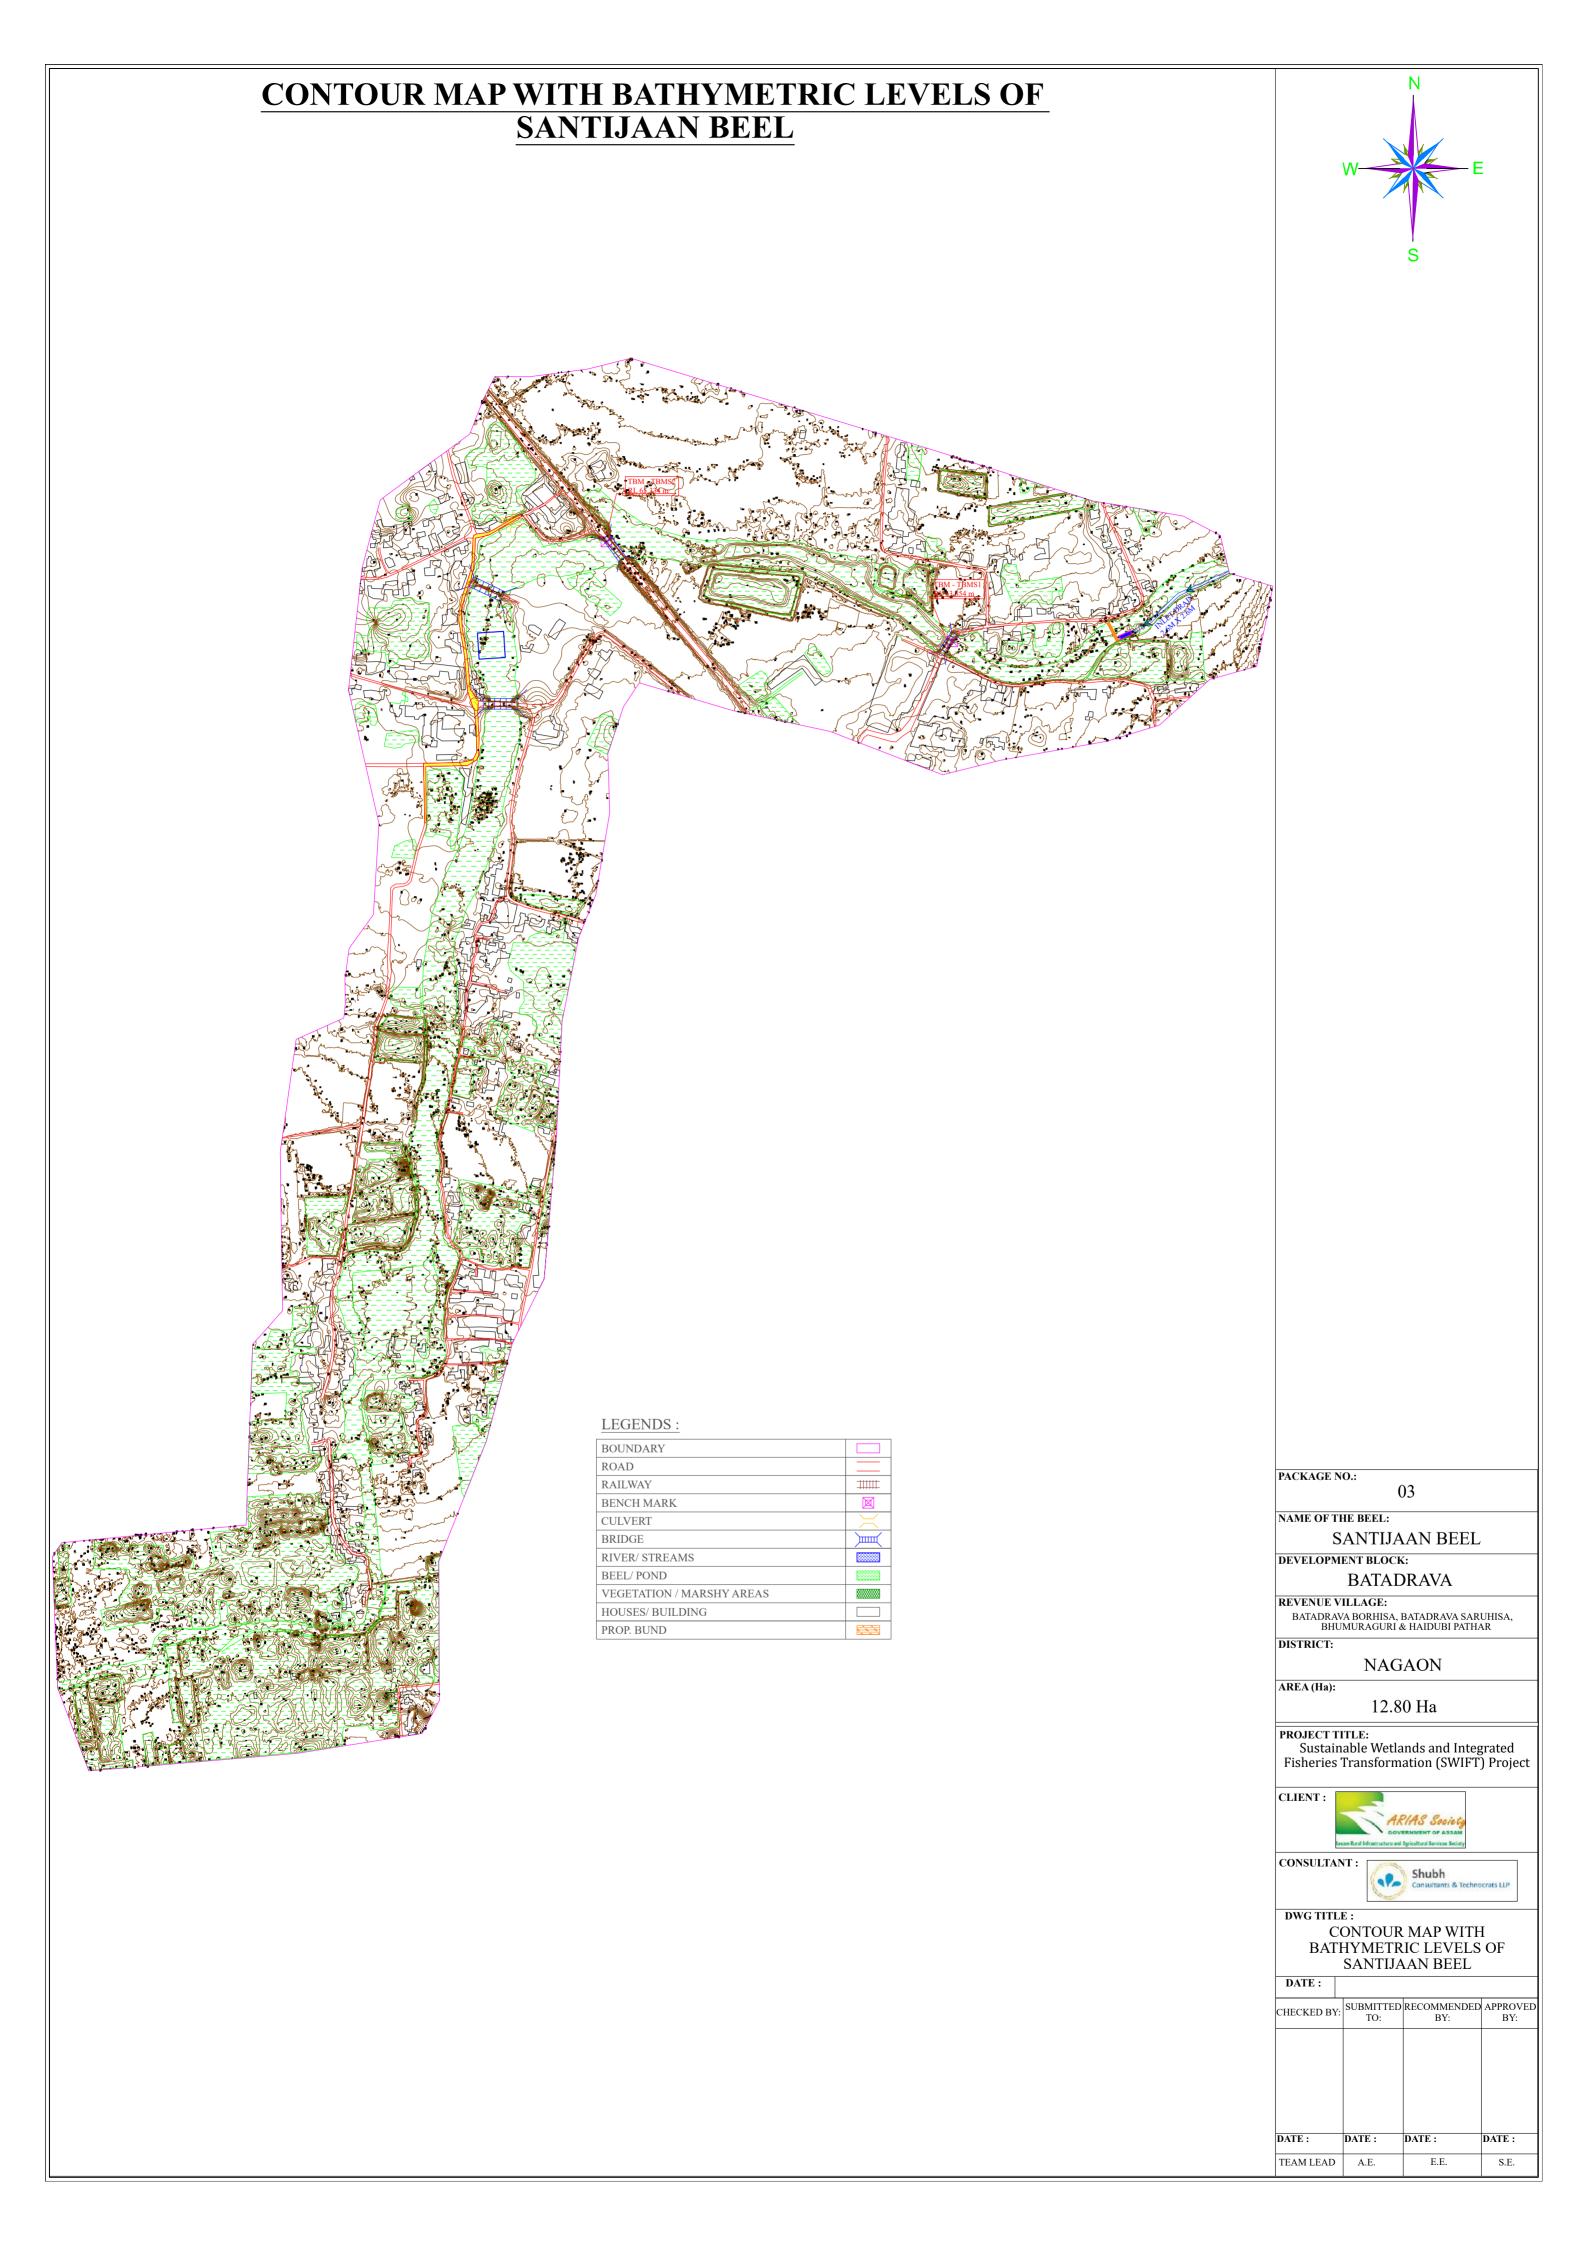



PACKAGE NO.:

03

NAME OF THE BEEL:

SANTIJAAN BEEL DEVELOPMENT BLOCK:

BATADRAVA

REVENUE VILLAGE:

BATADRAVA BORHISA, BATADRAVA SARUHISA,
BHUMURAGURI & HAIDUBI PATHAR

NAGAON

AREA (Ha):

12.80 Ha

PROJECT TITLE:
Sustainable Wetlands and Integrated
Fisheries Transformation (SWIFT) Project

CLIENT:



CONSULTANT:




DWG TITLE:

DRONE SURVEY MAP OF SANTIJAAN BEEL

DATE: CHECKED BY: SUBMITTED RECOMMENDED APPROVED DATE: DATE: DATE: DATE: TEAM LEAD E.E. S.E.

TYPICAL PLAN & SECTION OF REARING TANK

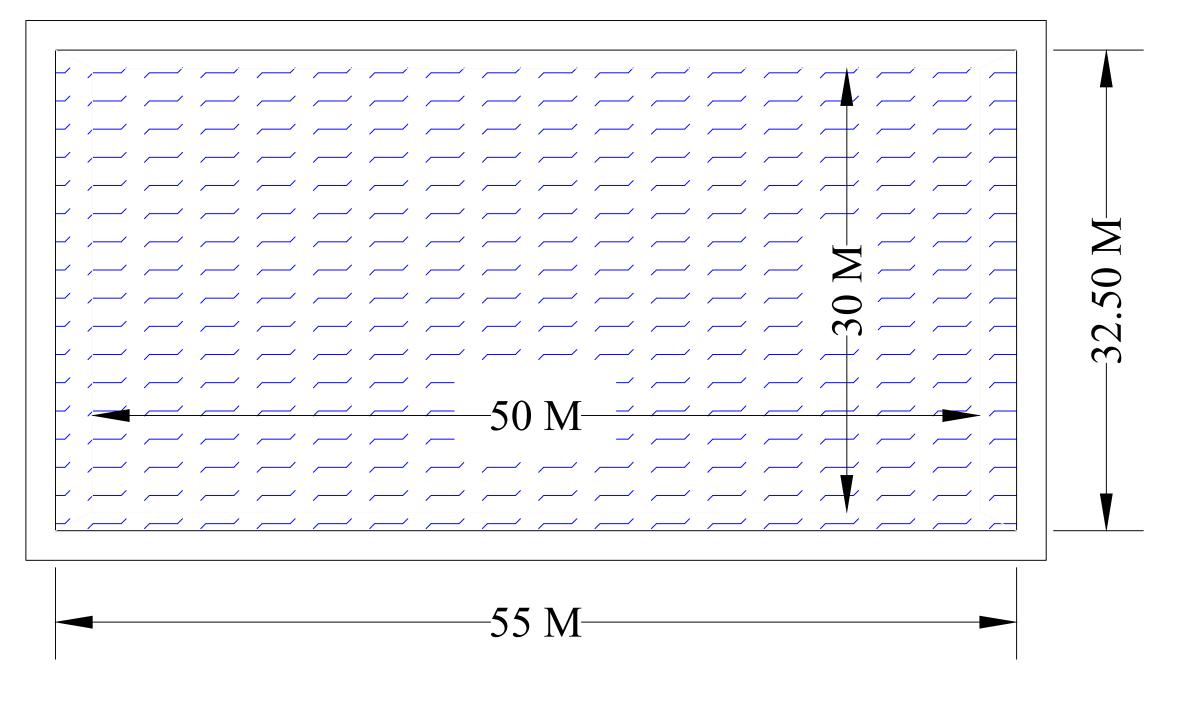

PLAN



SECTION

SCALE: NOT TO SCALE

PROJECT TITLE:

Sustainable Wetlands and Integrated Fisheries Transformation (SWIFT) Project





CONSULTANT:




DWG TITLE


TYPICAL PLAN & SECTION OF REARING TANK OF 1800 SQM


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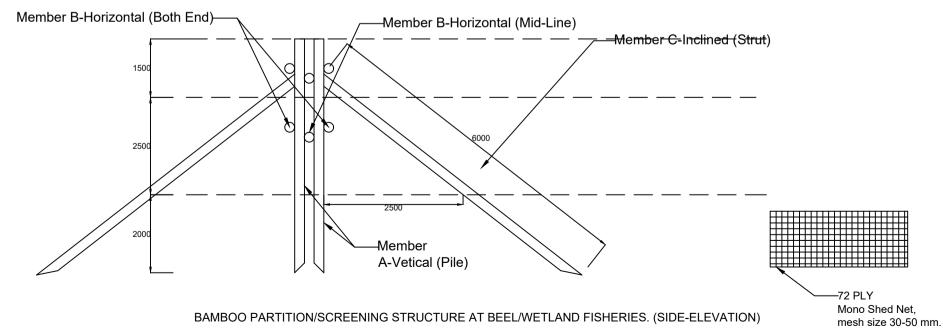


PEN CULTURE STRUCTURE AT BEEL/WETLAND FISHERIES. (FRONT-ELEVATION)

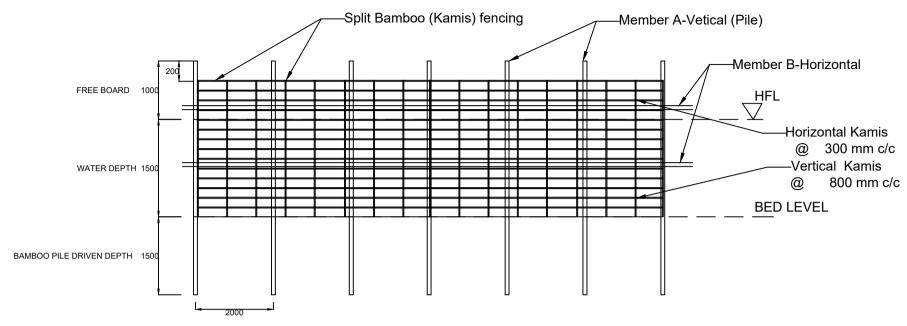


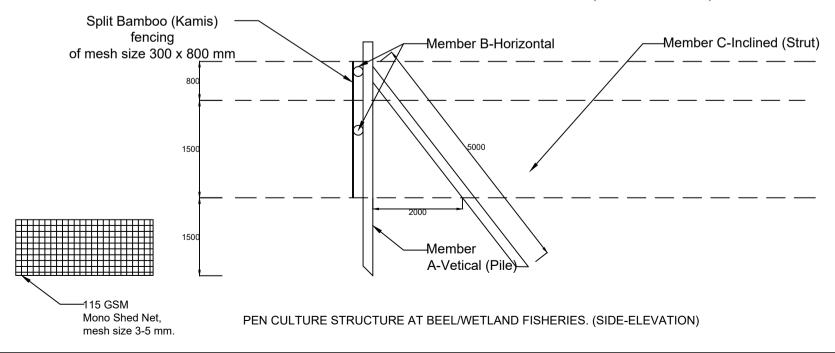



BAMBOO PARTITION/SCREENING STRUCTURE AT BEEL/WETLAND FISHERIES. (FRONT-ELEVATION)

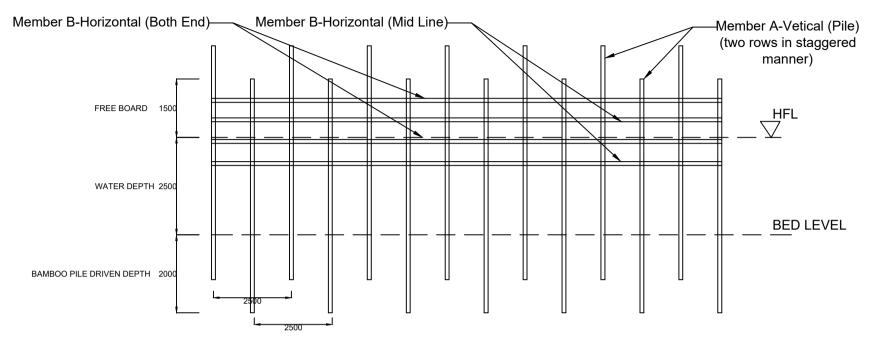


TYPICAL SECTION OF APPROACH ROAD

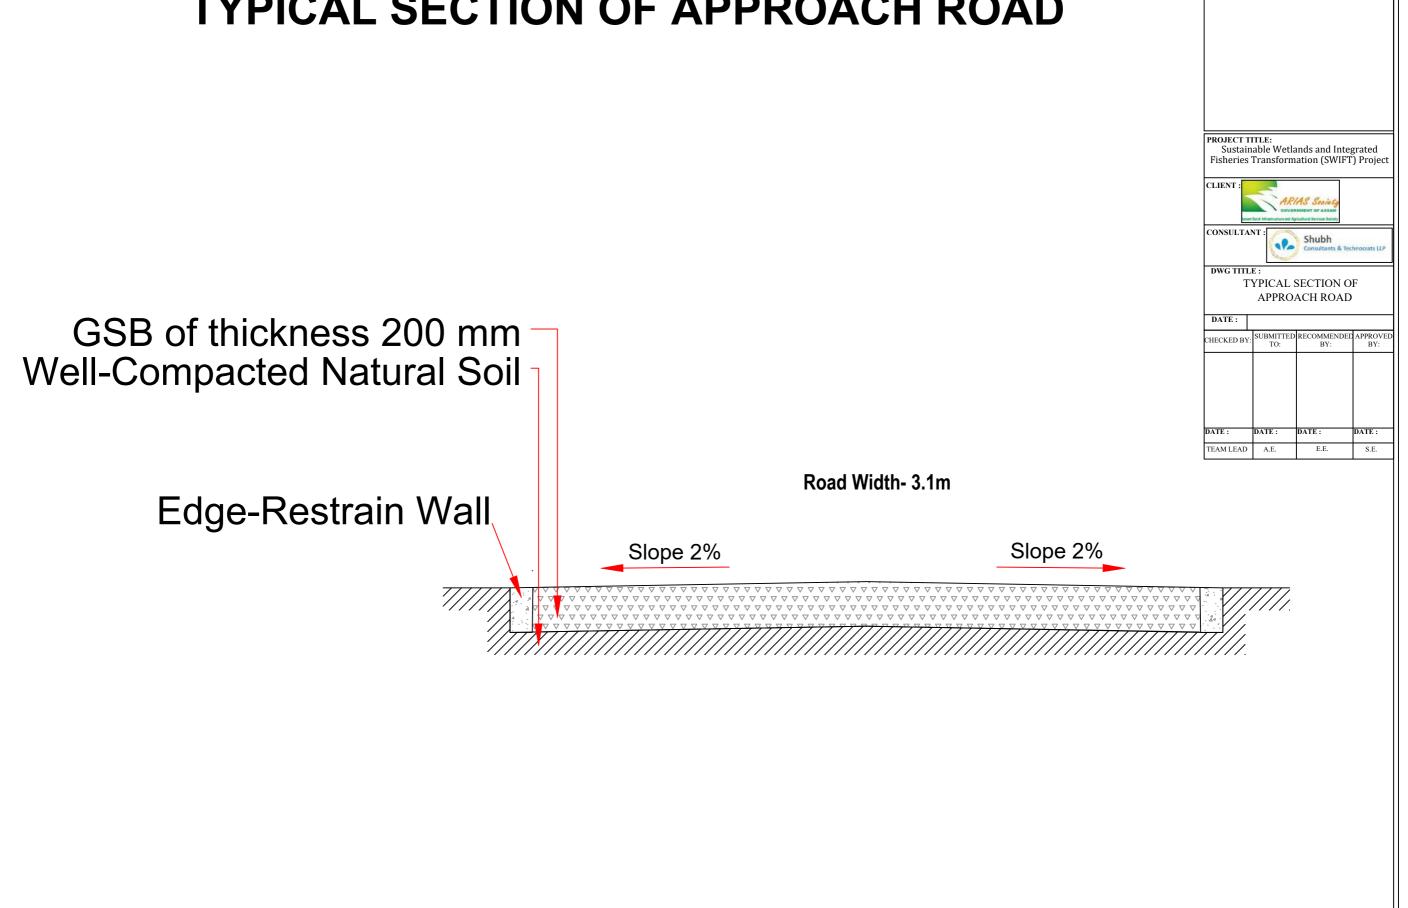


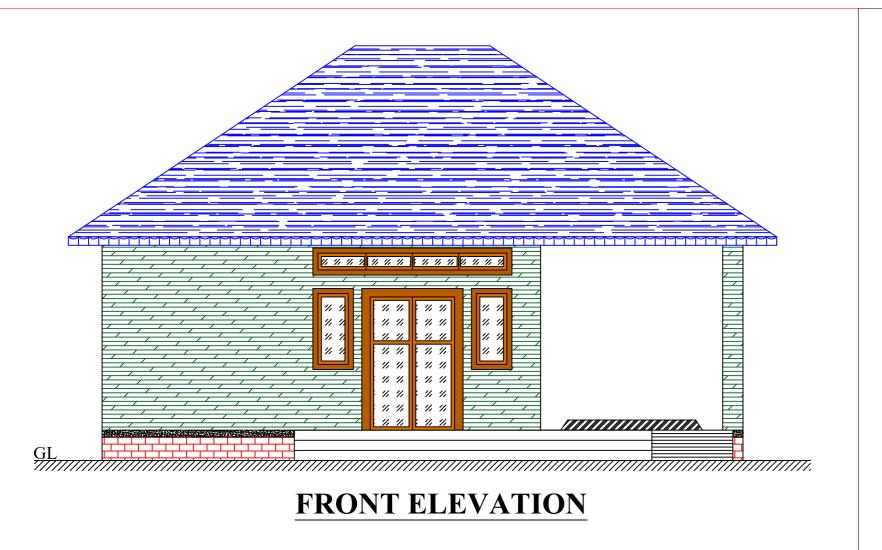


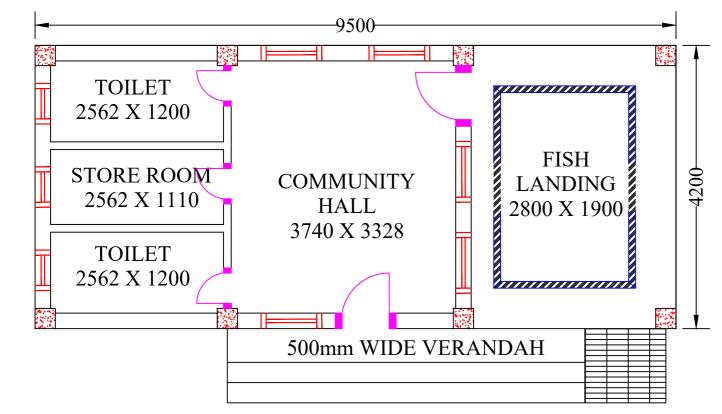

PLAN

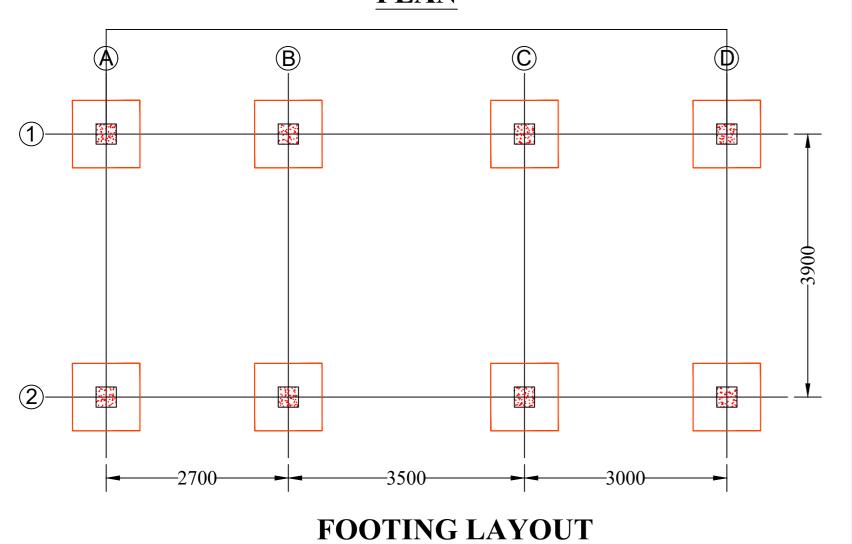

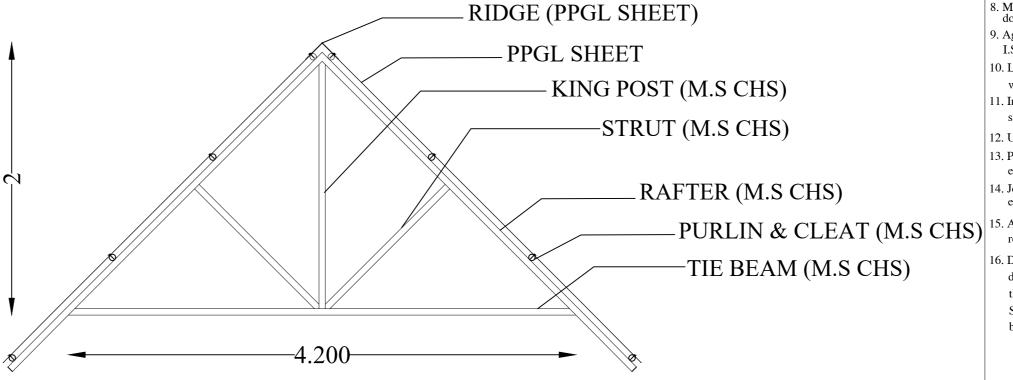

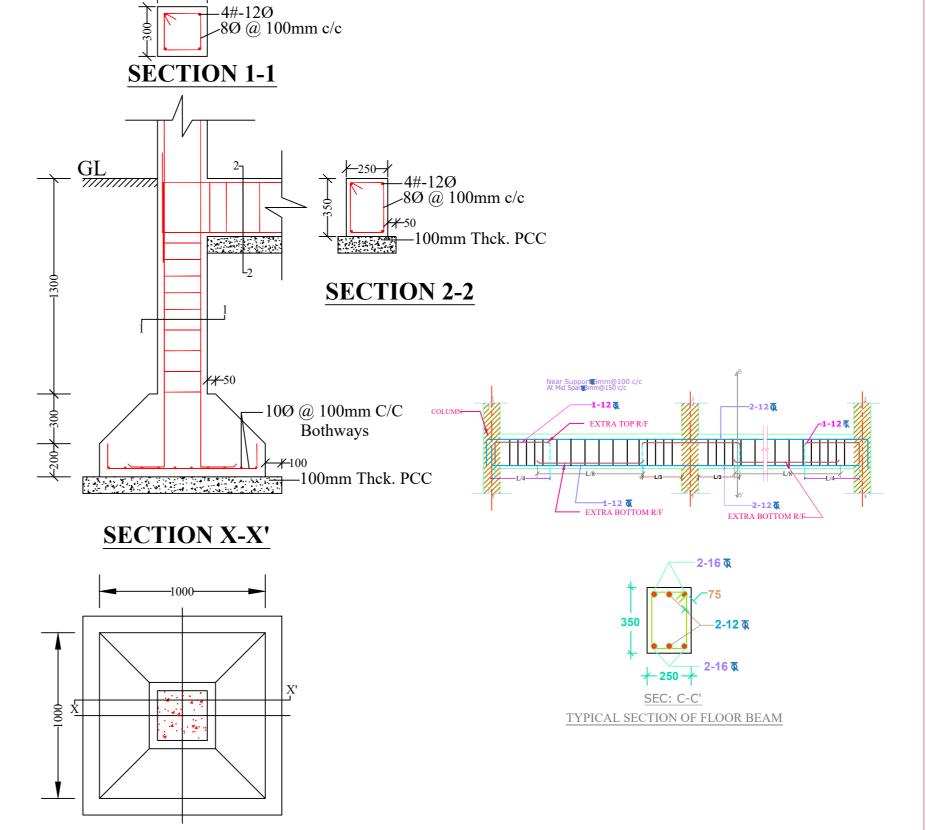

FOOTING PLAN

NOTES:

- 1. All dimensions are in millimetres.
- 2. All dimensions are to be read and not to be scaled.
- 3. Grade of Concrete used: M-20.
- 4. Grade of Steel Reinf. used: TMT (Grade-500) 5. Clear cover for reinf. bars:
- i) In Foundations 50 mm.
- ii) In Columns 40 mm.
- 25 mm. iii) In Beams
- 20 mm. iv) In Slabs
- 6. Not more than one third of the total number of main bars shall be over-lapped at any section of a column.
- 7. Laps, anchorage of reinf. bars shall be as per I.S.456-2000. 8. Maximum size of Coarse Aggregate shall be 20 mm and
- 9. Aggregate shall comply with the requirements of
- I.S.:383-1970.
- 10. Lap / Development length = 50 x 'd'
- where, 'd' = diameter of reinforcing bar. 11. In addition to Lintels, R.C.C. band at sill level
- should also be provided.
- 12. Use R.C.C. bands also in all vertical sides of openings. 13. Protruding rods to be provided in columns for
- embedding all brick walls.
- 14. Joints between walls & beams may be embedded with epoxy based joint filling compounds.
- 15. All Reinforcement detailing should meet all the general requirements of IS:4326 and IS:13920.
- 16. Dimensions shall be in conjunction with Architectural drawings. Architectural drawings shall be followed in the event of any discrepancy with due regard to the Structural requirements. Any major deviations shall be brought to the notice of the Engineer-in-charge.

SCALE: NOT TO SCALE

PROJECT TITLE:

Sustainable Wetlands and Integrated Fisheries Transformation (SWIFT) Project

CLIENT:

ARIAS SOCIETY


CONSULTANT:

SHUBH CONSULTANTS AND TECHNOCRATS LLP

DWG TITLE : STANDARD DRAWING
PLAN & CROSS-SECTION OF FISH LANDING SHED CUM COMMUNITY CENTRE

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CHECKED BY	SUBMITTED TO:	RECOMMENDED BY:	APPROVED BY:
DATE:	DATE:	DATE:	DATE:
TEAM LEAD	A.E.	E.E.	S.E.

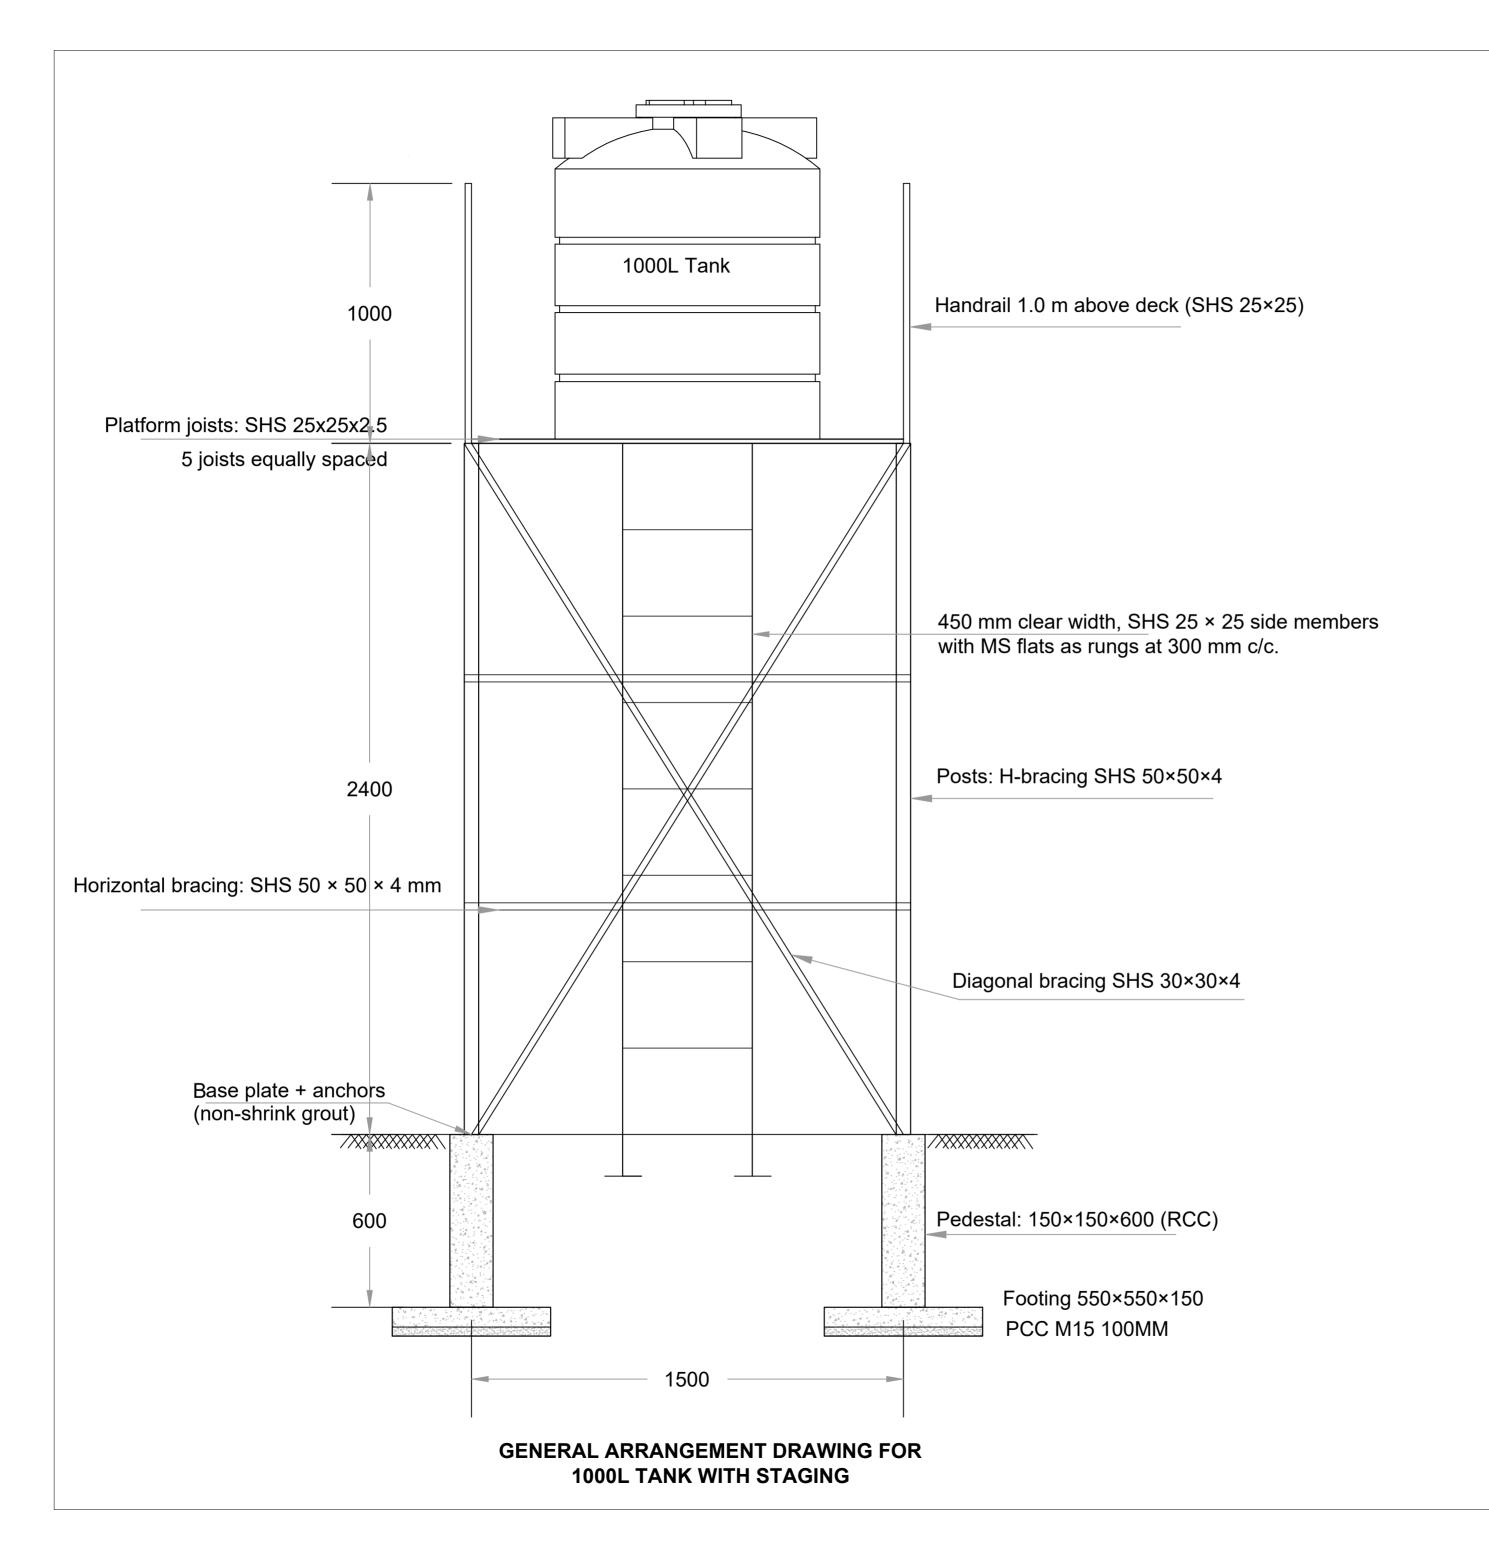

GENERAL NOTES -

Drawing Basis

- All dimensions are in millimetres (mm) unless otherwise stated.
- Dimensions shall be verified on site prior to construction; discrepancies to be reported to Engineer-in-Charge.

Concrete Works

- Footing: 550 × 550 × 150 RCC M20 (IS 456, IS 3370).
- Pedestal: 150 × 150 × 600 RCC above footing.
- Provide PCC 1:5:10, 100 mm thick blinding below footings (recommended).
- All reinforcement Fe-500D TMT; cover to reinforcement = 40 mm (footings/pedestals).

Steel Works

- Main posts: SHS 50 × 50 × 4 mm.
- Horizontal bracing: SHS 50 \times 50 \times 4 mm (at two intermediate levels).
- Diagonal bracing: SHS 30 × 30 × 4 mm.
- Platform joists: 5 nos. SHS 25 × 25 × 2.5 mm at equal spacing.
- Handrail: SHS 25 × 25 × 2.5 mm, 1.0 m high above deck.
- Ladder: 450 mm clear width, SHS 25 × 25 side members with MS flats as rungs at 300 mm c/c.
- All steel to conform to IS 2062; fabrication as per IS 800.

Connections & Base Plates

- Provide MS base plates (10 mm thick) at post bottoms, anchored into pedestal with 4 nos. 16 mm dia foundation bolts, grouted with non-shrink grout.
- Provide stiffener cleats, gusset plates, and welds as per design.
- All bolts/welds to conform to IS 1367/IS 816.

Corrosion Protection & Painting

- Structural steel to receive one coat zinc-rich primer + 2 coats epoxy/polyurethane paint (minimum 100 microns DFT).
- Alternatively, all steel members may be hot-dip galvanized (minimum 80 microns zinc coating).

Tank & Plumbing

 Water tank: 1,000 litres capacity, IS 12701 marked, provided with cover and locking arrangement.

PROJECT TITLE:

Sustainable Wetlands and Integrated Fisheries Transformation (SWIFT) Project

CLIENT: ARIAS SOCIETY


CONSULTANT: SHUBH CONSULTANTS AND TECHNOCRATS LLP


DWG TITLE:

STANDARD DRAWING


1000L TANK WITH STAGING

DATE:			
CHECKED BY	SUBMITTED TO:	RECOMMENDED BY:	APPROVED BY:
TEAM LEAD	A.E.	E.E.	S.E.

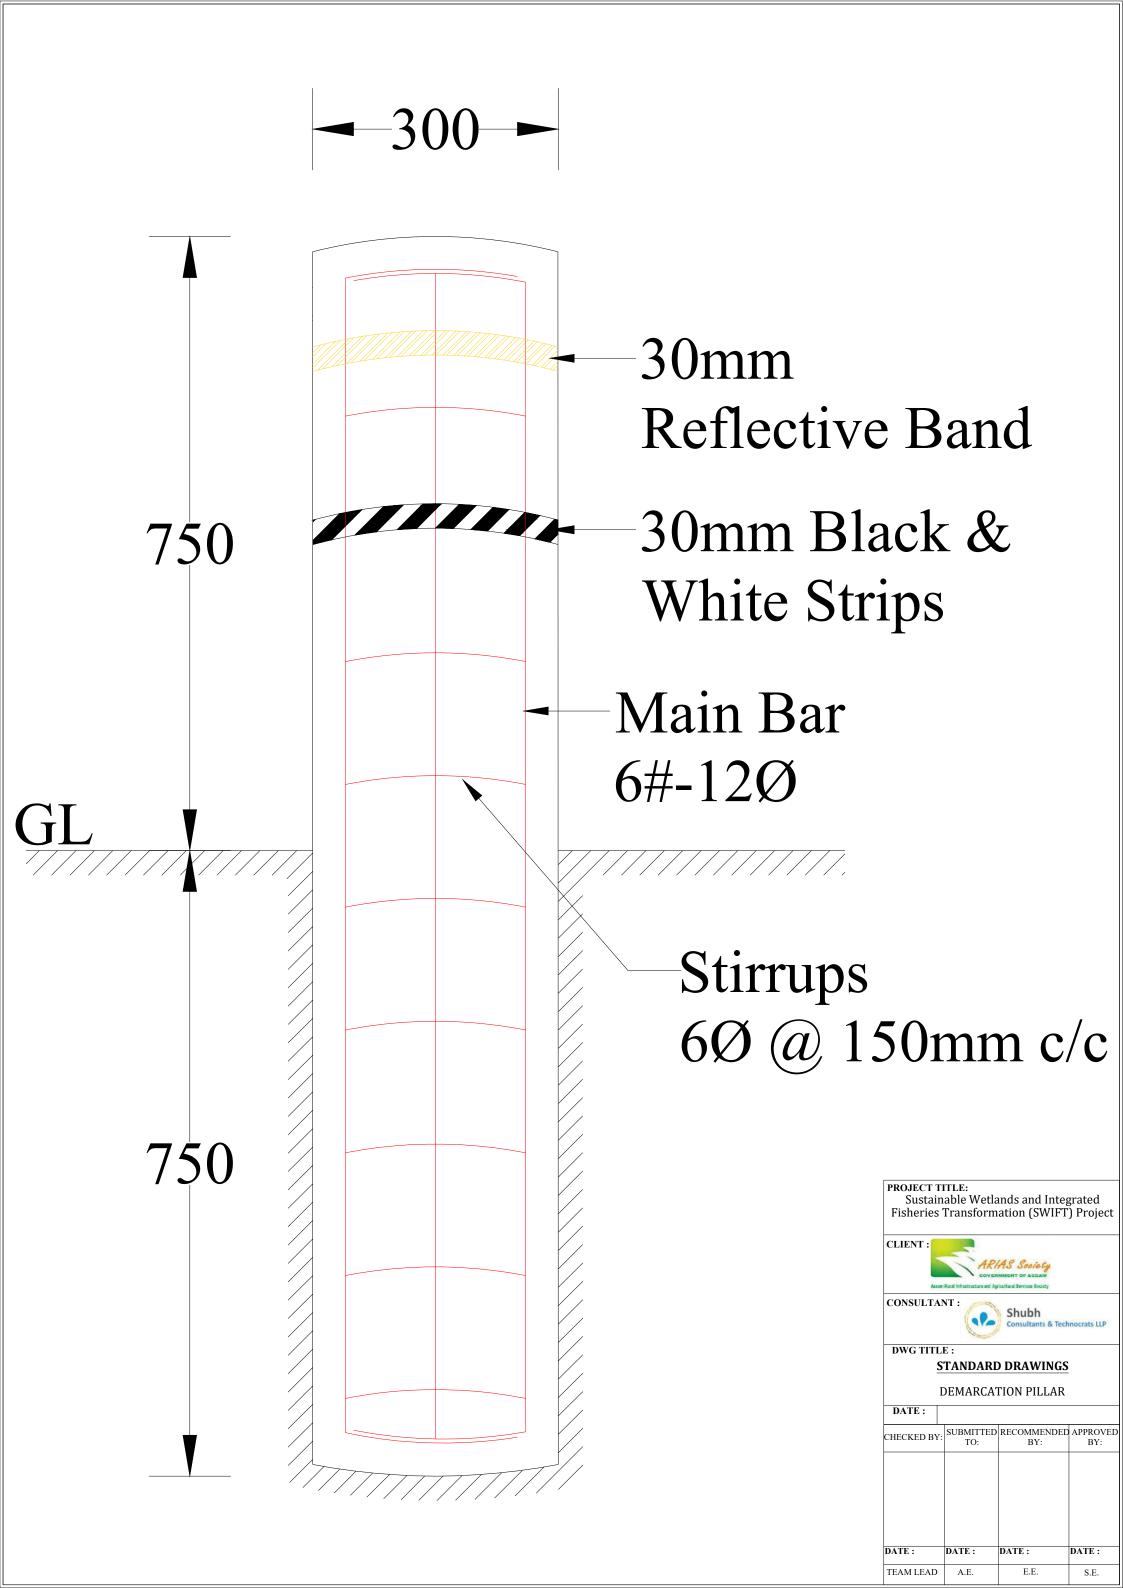


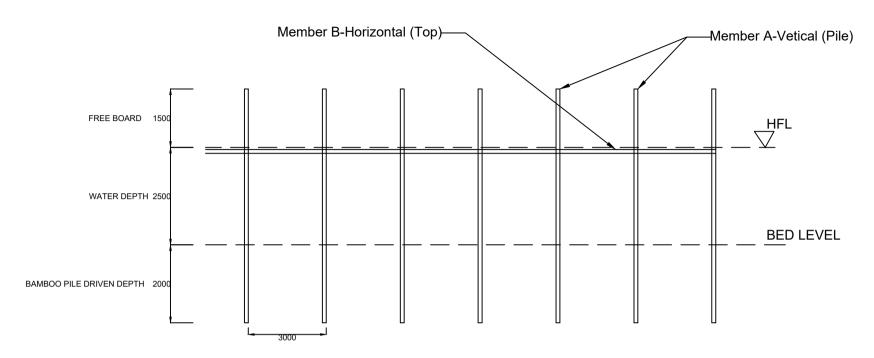

KATAL/CATTLE FISHING STRUCTURE AT BEEL/WETLAND FISHERIES. (FRONT-ELEVATION)

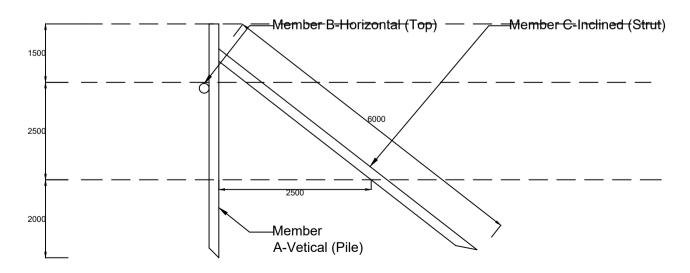

KATAL/CATTLE FISHING STRUCTURE AT BEEL/WETLAND FISHERIES. (SIDE-ELEVATION)

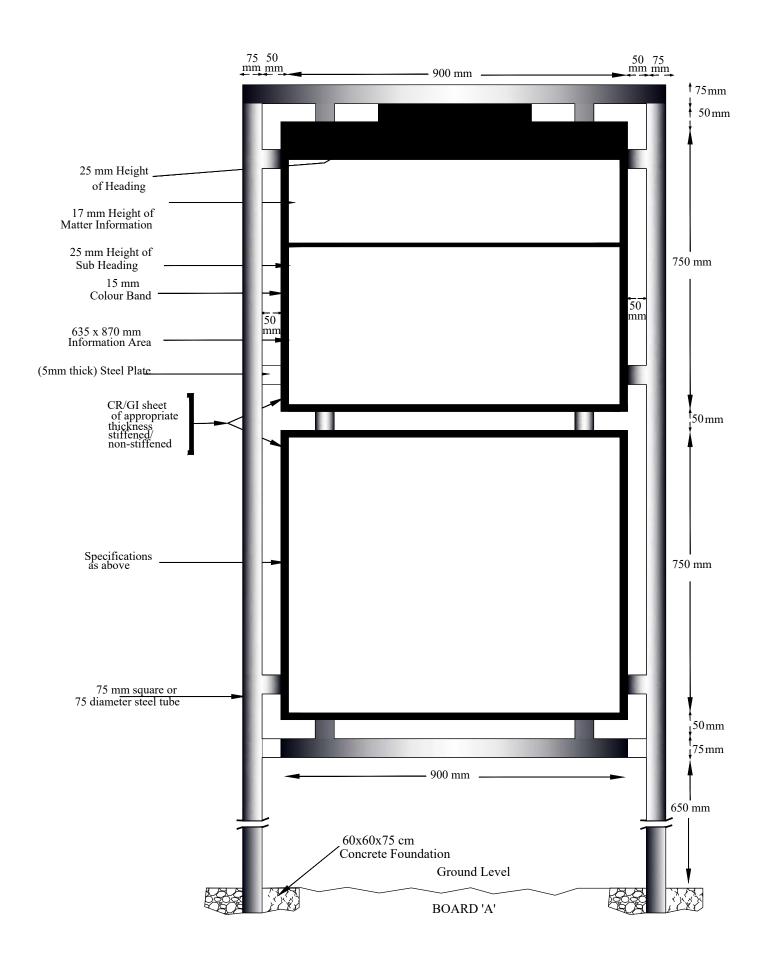

PROJECT TITLE:

Sustainable Wetlands and Integrated Fisheries Transformation (SWIFT) Project

CLIENT: ARIAS SOCIETY

CONSULTANT: SHUBH CONSULTANTS AND TECHNOCRATS LLP

DWG TITLE:

STANDARD DRAWING

INFORMATION BOARD

DATE:

CHECKED BY:	SUBMITTED	RECOMMENDED	APPROVEE
	TO:	BY:	BY:
TEAM LEAD	A.E.	E.E.	S.E.